Macarthur Memorial Park Masterplan ST ANDREWS ROAD, VARROVILLE EXISTING CPW TREES PROPOSED STREET TREES PROPOSED CPW TREES LOW SCREEN PLANTING LAWN AND EXISTING CONTOURS BURIAL ROOMS EXISTING AND PROPOSED WATERCOURSES PROPOSED ROADS AND CARPARKS GATEWAY SCULPTURE SCULPTURE PROPOSED HERITAGE CURTILAGE NO BUILD AREA PUBLIC OPEN SPACE VARROVILLE HOUSE : CHAPEL : OFFICE Issue: Rev: Description: Date: 18,09,2017 MACARTHUR MEMORIAL PARK VARROVILLE ROAD Drawing title: ANDREWS SITE MASTERPLAN WATER EASEMENT SECONDARY ENTRANCE CRYPTS SECONDARY ENTRANCE SERVICE ENTRANCE PEDESTRIAN ENTRANCE Florence Jaquet Landscape architect Macarthur Memorial Taik Gunc, Companion, Cita BOARDWALK 'TIMELINE' WALK GATEWAYS • PICNIC AREAS Job no: 1210 Drawn by: Checked by: Scale: 1:2500 CAD file name: L100 OVERALL SITE PLAN.dwg Sheet no:

STAGING 9.

STAGE 1 (From 2019 to 2104)

- · All buildings and services constructed.

- All buildings and services constructed.
 Outbuildings restoration.
 Entrances A to C.
 All roads within Stage 1 only (to the extent permissible under Bushfire Regulation).
 All landscaping and furniture within Stage 1.
 Shelters as required.
 The rest of the site remains UNCHANGED.

- The rest of the site remains UNCHANGED.

STAGE 2 (From 2105 to 2130)

- · All roads within Stage 2 only
- All landscaping and furniture within Stage 2.
- · Shelters as required.
- The rest of the site remains UNCHANGED.

STAGE 3 (From 2131 to 2140)

- All roads within Stage 3 onlyAll landscaping and furniture within Stage 3.
- · Shelters as required.
- · The rest of the site remains UNCHANGED.


STAGE 4 (From 2141 to 2155)

- All roads within Stage 4 only
 All landscaping and furniture within Stage 4.
 Shelters as required.
- Entrance D
- · The rest of the site remains UNCHANGED.


STAGE 5 (From 2156 to 2170)

- · All roads within Stage 5.
- · All landscaping and furniture within Stage 5.
- Shelters as required.

The above stages are based on current statistical information and projections.

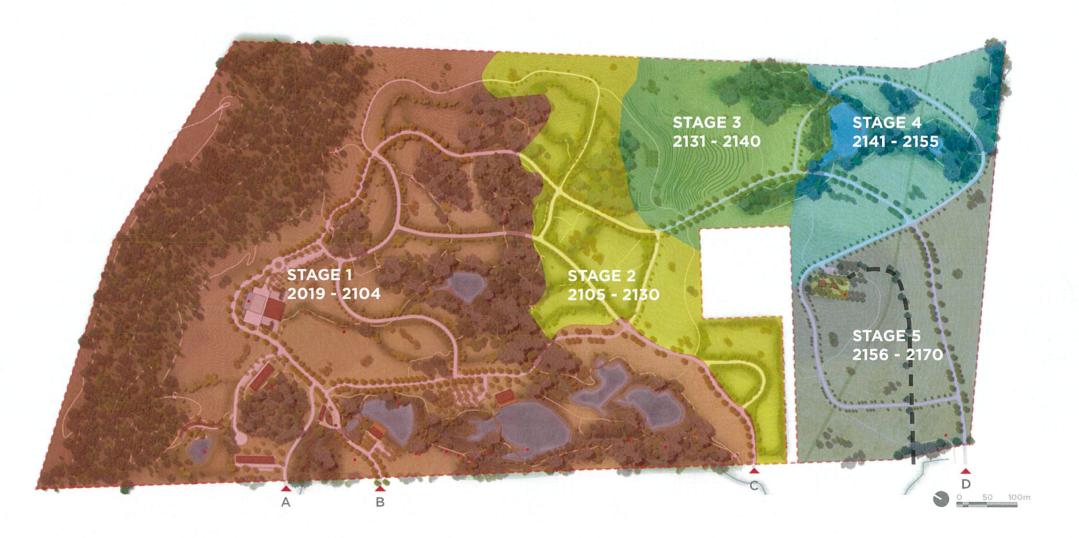

7.5 LAWN BURIALS

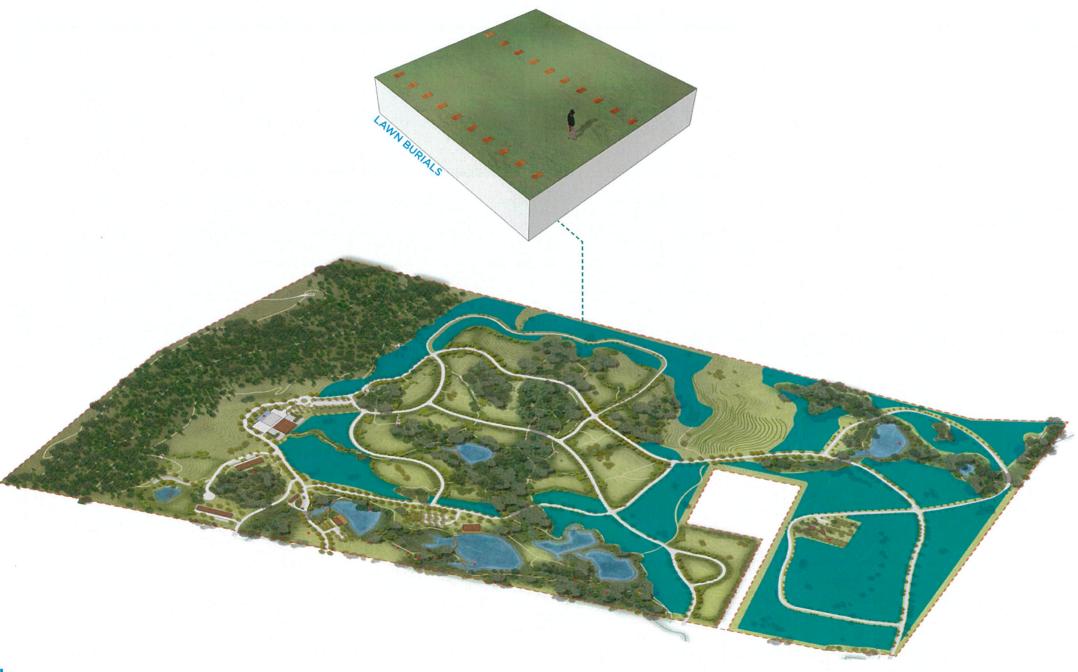

DESIGN PRINCIPLES

- ContemporaryRespect visual quality of the siteIn harmony with the environment

- · Memorialisation only allowed as a plaque flush with
- Memorialisation only allowed as a plaque flush with lawn.
 Concealed concrete beams below ground (necessary to avoid subsidence)
 Minimise visual impact of cemetery from the main road.
- Generally, grave rows follow existing contouring of the land.
- Re-grading only where localised water ponding may occur.

 • Provide occasional specimen tree for shade and
- respite.

NATURAL BURIALS 7.6




DESIGN PRINCIPLES

- Unique
 Contemporary
 Respect visual quality of the site
 Respect mourning process
 In harmony with the environment

- · Chemical free and 100% biodegradable coffin or
- Biodegradable grave markers (wood) or none.
- · Grave location to be recorded and marked with steel pegs in the ground (traceable with metal detector).
- · Double depth of burial allowed.
- Set within an existing pocket of Cumberland Plain Woodland (CPW).
- · First natural (green) burial set in CPW.
- · Low impact on existing root space system.
 - Grave plots to radiate out of the SRZ to minimise root damage (running in same direction as structural roots). Only 5 burials allowed around each tree per 5 years period to allow for root regeneration.
 - · Ash interment to be limited in numbers and buried in the Structural Root Zone (SRZ). Only requires a small 300mm deep hole.
- · Restore grave surface with site topsoil and plant
- · Bushland setting with denser perimeter plantings for privacy.

7.7 **BURIAL ROOMS**

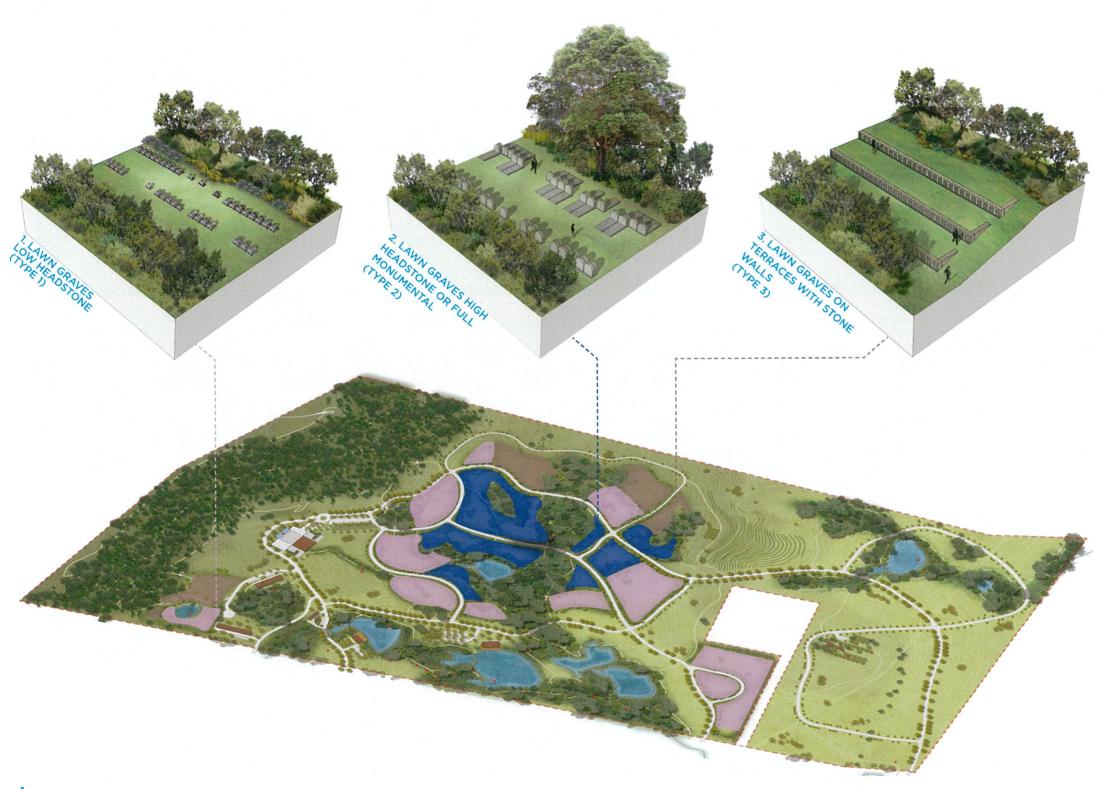

DESIGN PRINCIPLES


- Unique

- Contemporary
 Respect visual quality of the site
 Respect mourning process
 In harmony with the environment

- Minimise visual impact of cemetery from the main internal and external roads, Campbelltown township,
- Varroville house and Hume highway.

 Create "burial rooms" to conceal all headstones and memorialisation from the main roads and Varroville house.
- Provide screening in the form of native planting of varying height, ensuring the planting blends into the existing rural and CPW landscape.
 Avoid using exotic tree species which may clash with
- heritage landscape.
 Set the "burial rooms" against the backdrop of the
- existing and future CPW zones.
 Provide 3 types of "burial rooms":
- - Lawn graves
 Low headstones (700mm max) on concrete beams in a lawn setting (Type 1).
 - 2. Lawn graves
 - 2. Lawn graves
 High headstones (1.2m high max) on concrete
 beam or full monumental (Type 2).
 3. Lawn graves on terraces
 Stone retaining walls with headstones recessed
 into wall face (Type 3).
- Provide ash memorialisation options within each "burial room", typically located along the edge of the screen planting (internally only). (Refer to Ash Interments for more details)

7.8 **BURIAL SUB-ROOMS**

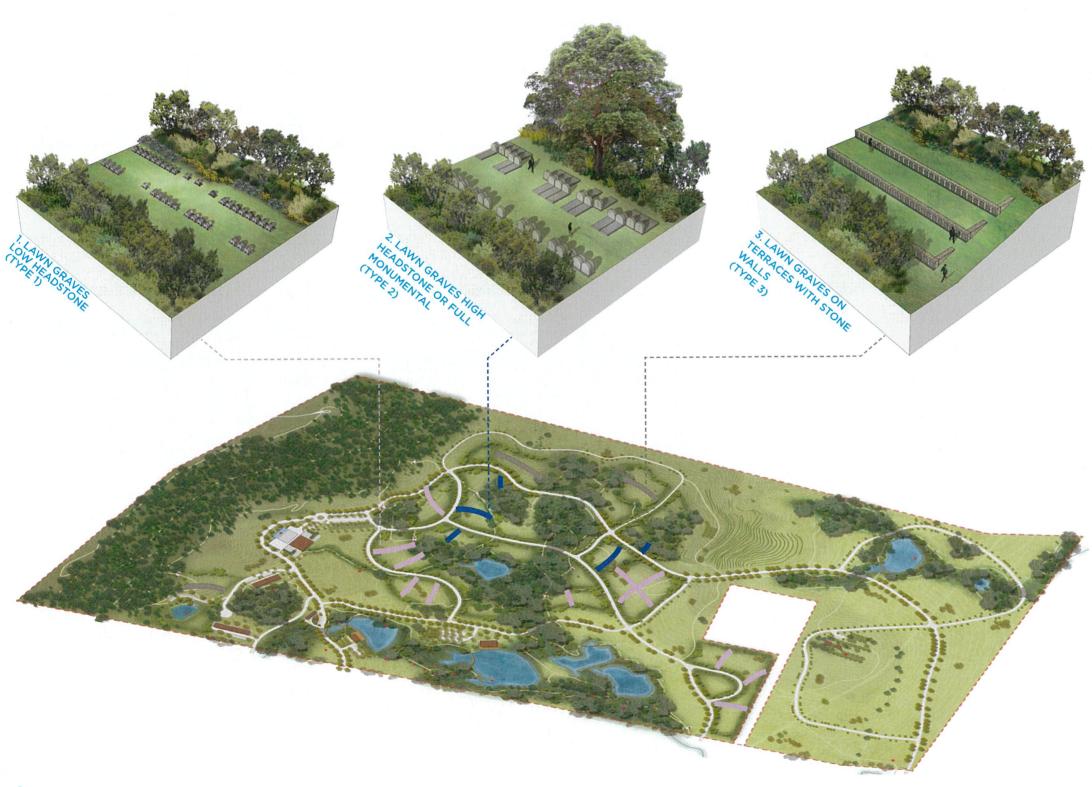

DESIGN PRINCIPLES

- Unique
 Contemporary
 Respect visual quality of the site
 Respect mourning process
 In harmony with the environment

- · Within each burial room, sub-divide into small
- spaces using separation planting of max 1.8m height.

 Provide privacy for mourners in a smaller, more human scale space.

- Allow views through in places for passive policing.
 Each sub-burial room will host between 750 and 1200 grave positions.
 Allocation of room to each cultural or religious group will be dependent on demand over the 150 years life of the cemetery.

7.9 **ASH INTERMENTS**



DESIGN PRINCIPLES

- UniqueContemporaryRespect visual quality of the site
- Respect visual quanty of the site
 Respect mourning process
 In harmony with the environment
 In line with design narrative
- Sculptural

- · Minimise visual impact of cemetery from the main internal and external roads.
- · Provide new and sculptural designs in keeping with design rationale.
- Complimentary to the 'Park-like' setting and public activities within.
- Provide a variety of 'Ash interment option' varying in prices, aesthetics and cultural relevance:
 - 1. Within 'Memorial Gardens' which are more compactly laid out. Memorialisation will be more intensified in key location. Each garden will have a theme.(native, colour, scented, music...)
 - 2. Natural/green burial, biodegradable markers, set only within the Structural Root Zone (SRZ) of existing and proposed trees.
 - 3. Within the burial rooms and sub-rooms, typically located along the edge of the screen planting's garden beds (internally only). Along all path networks which are within 50m of a road. Memorialisation will be more sculptural to compliment the 'park-like' setting as these paths will also be used for recreation.
 - 4. Along all path networks which are within 50m of a road. Memorialisation will be more sculptural to compliment the 'park-like' setting as these paths will also be used for recreation.

7. DESIGN ELEMENTS

7.9 ASH INTERMENTS



- Associated with a tree
 This is particularly appealing to families and couples and ensures long term funding of tree maintenance and replacement.
- Associated with a sculpture
 This is particularly appealing to families and assists with the long-term maintenance funding.
- 7. Associated with seating
- 8. Associated with heritage items
 Memorialisation is part of an integrated design
 response to significant heritage items and forms
 part of the site's adaptive re-use. As such, it
 ensures a continuing maintenance of these
 items by allowing income generation within key
 elements.
- In general, cremation are kept in standard plastic urns and buried in the close proximity of the memorial plaque(behind, in front or below).